
NAVARRO INN STABILIZATION PLAN


GENERAL NOTES

- 1. THE FOLLOWING NOTES ARE INCLUDED AS INFORMATION PERTAINING DIRECTLY TO THIS SET OF DRAWINGS. PROJECT SPECIFICATIONS SHOULD BE EXAMINED BY THE CONTRACTOR FOR THE BALANCE OF THE SCOPE OF THIS PROJECT.
- 2. ALL WORK SHALL CONFORM TO THE CALIFORNIA BUILDING CODE, 2007 EDITION, STATE HISTORIC BUILDING CODE, AND ALL LOCAL, STATE AND NATIONAL REGULATIONS.
- 3. BRING ANY ERRORS OR OMISSIONS IN THESE DRAWINGS AND PROJECT SPECIFICATIONS TO THE ATTENTION OF THE STATE REPRESENTATIVE IMMEDIATELY.
- 4. THE CONTRACTOR SHALL VERIFY ALL FIELD CONDITIONS. ANY NECESSARY ADJUSTMENTS BETWEEN FIELD CONDITIONS AND DRAWINGS SHALL BE BROUGHT TO THE ATTENTION OF THE STATE REPRESENTATIVE FOR RESOLUTION.
- 5. DO NOT SCALE DRAWINGS. THE CONTRACTOR SHALL BE RESPONSIBLE FOR VERIFYING FIELD MEASUREMENTS BEFORE ORDERING MATERIALS AND PREFABRICATED ITEMS. ANY NECESSARY ADJUSTMENTS BETWEEN FIELD MEASUREMENTS AND DRAWINGS SHALL BE BROUGHT TO THE ATTENTION OF THE ARCHITECT FOR RESOLUTION.
- 6. ALL MATERIAL & WORKMANSHIP SHALL CONFORM TO THE DRAWINGS AND SPECIFICATIONS. WRITTEN INFORMATION TAKES PRECEDENCE OVER GRAPHIC REPRESENTATION
- 7. CONTRACTOR SHALL BECOME THOROUGHLY FAMILIAR WITH THE DRAWINGS AND SPECIFICATIONS BEFORE UNDERTAKING THE WORK OF THIS PROJECT. CONTRACTOR SHALL NOTIFY THE STATE REPRESENTATIVE OF ANY DISCREPANCIES BETWEEN THE EXISTING SITE CONDITIONS AND INFORMATION AS REPRESENTED IN THE DRAWINGS AND SPECIFICATIONS.
- 8. THE INTENT OF THE CONTRACT DOCUMENTS IS TO PROVIDE FOR THE CONSTRUCTION OF A COMPLETE AND WORKABLE PROJECT. WHERE APPLICABLE TO THE DOCUMENTS THE FOLLOWING SHALL APPLY: EXTERIOR ASSEMBLIES SHALL BE WEATHER RESISTANT: AND STRUCTURAL SYSTEMS SHALL BE ABLE TO PERFORM TO THEIR MAXIMUM DESIGN CRITERIA. THE CONTRACTOR SHALL MEET THIS INTENT, BRINGING TO THE ATTENTION OF THE STATE REPRESENTATIVE FOR RESOLUTION ANY ERRORS OR INCONSISTENCIES DISCOVERED IN THE DRAWINGS AND SPECIFICATIONS, PRIOR TO COMMENCING WORK. CONTRACTOR SHALL BRING ALL SUCH ISSUES TO THE ATTENTION OF THE STATE REPRESENTATIVE IMMEDIATELY UPON DISCOVERY AND PRIOR TO COMMENCING ANY WORK RELATED TO THE ISSUE.
- 9. ALL CHANGES TO THE CONTRACT DOCUMENTS SHALL BE AUTHORIZED IN WRITING BY MEANS OF CHANGE ORDERS. CLARIFICATIONS, TO ASSIST THE CONTRACTOR, SHALL NOT BE MISCONSTRUED TO BE AUTHORIZED CHANGES.
- 10. CONTRACTOR SHALL VISIT THE JOB SITE TO VERIFY EXISITING CONDIITIONS, AND NOTIFY THE STATE REPRESENTATIVE OF ANY PERCEIVED DISCREPANCIES BETWEEN THE PLANS AND SITE CONDITIONS PRIOR TO COMMENCING WITH ANY WORK. CONTRACTOR SHALL VERIFY THAT THERE ARE NO CONDITIONS PREVAILING THAT WILL PREVENT A NORMAL, UNINTERRUPTED CONSTRUCTION PROCESS.
- 11. THE DRAWINGS INDICATE SPECIFIC, TYPICAL AND GENERAL DETAILS OF CONSTRUCTION. WHERE CONDITIONS ARE NOT SPECIFICALLY INDICATED BUT ARE OF SIMILAR CHARACTER TO DETAILS SHOWN, SIMILAR DETAILS OF CONSTRUCTION SHALL BE FOLLOWED FOR SETTING MINIMUM GUIDELINES AND QUALITY, SUBJECT TO REVIEW AND APPROVAL BY THE
- 12. ALL WORK SHALL BE PERFORMED IN ACCORDANCE WITH THE BEST STANDARD PRACTICE BY PEOPLE TRAINED AND EXPERIENCED IN THE TRADE IN WHICH THEY ARE WORKING. MATERIAL, UNLESS OTHERWISE NOTED, SHALL BE NEW AND OF THE QUALITY SPECIFIED OR BETTER.
- 13. CONTRACTOR SHALL PROTECT AGAINST DAMAGE TO ALL EXISTING COMPONENTS TO REMAIN, INCLUDING BUT NOT LIMITED TO UNDERGROUND UTILITIES, SITE WORK, LANDSCAPING, STRUCTURES AND ADJACENT PROPERTIES. DAMAGES TO SAME SHALL BE REPLACED OR REPAIRED TO THE SATISFACTION OF AND AT NO ADDITIONAL COST TO THE STATE
- 14. CONTRACTOR SHALL FOLLOW SENSITIVE RESOURCE PROTECTIONS CONTAINED IN SPECIFICATIONS REGARDING WETLANDS, BATS, ARCHAEOLOGICAL RESOURCES AND HISTORIC RESOURCES AT ALL TIMES.
- 15. ALL DEMOLITION MATERIALS NOT DESIGNATED TO BE SALVAGED, AND WASTE AND DEBRIS, SHALL BECOME THE PROPERTY OF THE CONTRACTOR AND SHALL BE REMOVED FROM THE SITE AND DISPOSED OF IN A SAFE AND LEGAL MANNER.
- 16. CONTRACTOR MUST BE THOROUGHLY FAMILIAR WITH CONTENT OF SECRETARY OF INTERIOR'S STANDARDS AND WILL BE RESPONSIBLE FOR ADHERENCE TO STANDARDS BY ALL EMPLOYEES AND SUBCONTRACTORS.
- 17. THE CONTRACTOR SHALL MAINTAIN AN ARTIFACT LOG OF HISTORIC ELEMENTS TO BE RETAINED. THE LOG SHALL BE A ADDITION TO ANY NOTES APPEARING IN THE DRAWINGS.

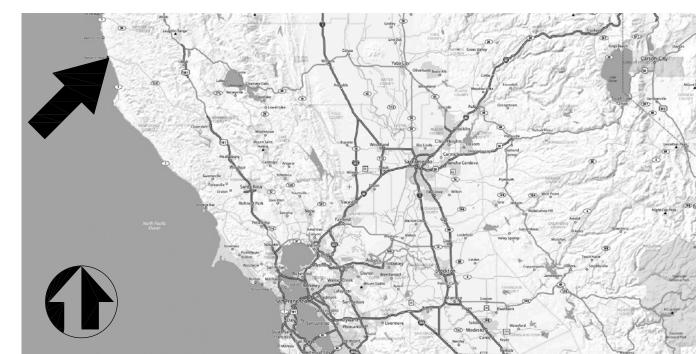





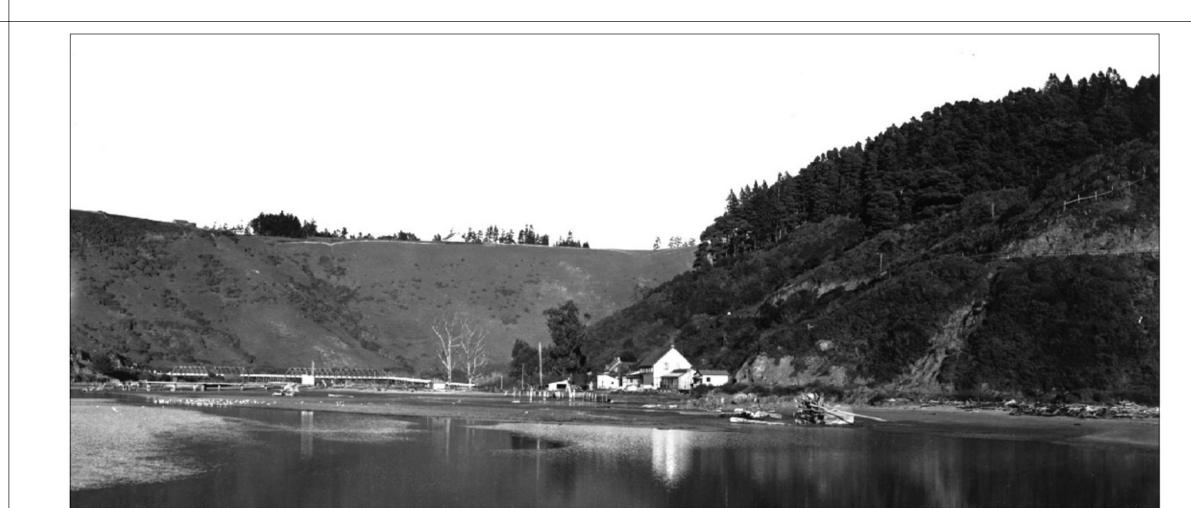

ABBREVIATIONS

Board
Building
Blocking
Beam
Basement
Built—up
Built—up Roofing
Between

Cement
Ceiling
Clear
Column
Concrete
Continuous
Center
Double
Deconstruct(ion
Detail
Diameter
Dimension
Door
Drawing

Existing
East
Each
Elevation
Electrical
Equipment
Exterior
Flat Bar
Finish
Floor
Flashing
Face of Concrete
Face of Studs

Maximum
Membrane
Metal
Minimum
Miscellaneous
Mounted
New
North
Not in Contract

Nominal Not To Scale

Redwood Reinforced

Retaining Required Room Rough Opening

Redwood Rain Water Leader

On Center Outside Diameter (Dim.) Opening Opposite

Plate Plywood Pressure Treated Painted Pressure Treated Douglas Fir

South
SEE ARCHITECTURAL DRAWINGS

SEE ELECTRICAL DRAWINGS

Similar SEE MECHANICAL DRAWINGS

Specification
Square
SEE STRUCTURAL DRAWINGS

Typical Unfinished Unless Otherwise Noted Vertical Grain Douglas Fir



SYMBOLS

DETAIL REFERENCE

FLOOR REFERENCE

SECTION REFERENCE

EXTERIOR ELEVATION

KEY NOTE

 $\frac{3}{\text{A1}}$

(3)



PROJECT TEAM

<u>ARCHITECTURAL</u>

Carey & Co. Inc 460 Bush Street San Francisco, CA tel 415.773.0773 Contact: Charlie Duncan

STRUCTURAL

Fulcrum Structural Engineering 665 Third Street Suite 333 San Francisco, CA tel 415.543.0161 x.11 Contact: Alex Rood

ELECTRICAL

Guttman & Blaevoet 2351 Powell Street San Francisco, California, 94133 tel 415.655.4000

<u>GEOTECH</u>

Jensen-Van Lienden Associates, Inc. 1840 Alcatraz Avenue Berkeley, CA 94703

<u>CIVIL</u>

Lee Welty, P.E. I.L. Welty & Associates 703 North Main Street Fort Bragg, CA 95437

PROJECT DESCRIPTION

NAVARRO INN SCOPE OF WORK

PHASE ONE - STABILIZATION AND SEISMIC UPGRADE TO THE HISTORIC CIRCA 1865 NAVARRO INN USING THE SECRETARY OF THE INTERIOR'S STANDARDS FOR THE TREATMENT OF HISTORIC PROPERTIES. THERE WILL BE NO OCCUPANCY AT THE COMPLETION OF THIS PHASE OF WORK.

I. REMOVE EXISTING SOUTHERN AND NORTHERN ADDITIONS AS SHOWN ON THE DRAWINGS. RETAIN HISTORIC BUILDING ELEMENTS INCLUDING BUT NOT LIMITED TO THE BAR, COOLER, AND FIXTURES IN DOWNSTAIRS BATH AND EASTERN UPSTARS BATH. HISTORIC ELEMENTS TO BE RETAINED ARE NOTED IN THE DRAWINGS. PRIOR TO REMOVAL, PHOTO-DOCUMENT ADDITION "B" ON THE INTERIOR AND EXTERIOR. REMOVAL OF ANY ADDITIONS WILLL INVOLVE THE CAREFUL REMOVAL AND SALVAGE OF ALL EXTERIOR SIDING AND USABLE HISTORIC ELEMENTS. ALL USABLE HISTORIC ELEMENTS TO ADDITION "B" SHALL BE RETAINED WITH THE INTENT OF REBULDING THIS ADDITION AT A LATER PHASE OF REHABILITATION.

- . REMOVE EXISTING PORCH AND SALVAGE ELEMENTS AS SHOWN ON THE DRAWINGS FOR RE-USE IN THE ALTERNATE ONE PORCH RECONSTRUCTION.
- DISMANTLE EXISTING CHIMNEY, FIREBOX AND MANTLE ELEMENTS. CATALOG AND SALVAGE FIREBOX, MANTLE, AND WALL COVERINGS REMOVED TO ACCESS CHIMNEY FOR DECONSTRUCTION AND RECONSTRUCTION IN A FUTURE PHASE. RETAIN ALL ELEMENTS OF CHIMNEY ASSEMBLY FOR RECONSTRUCTION. DOCUMENT ANY EVIDENCE OF EARLIER FIREPLACE/CHIMNEY CONSTRUCTION. STORE BRICKS FOR REUSE ON SITE AS SHOWN IN DRAWINGS, CLOSE OPENING AT ROOF AT CHIMNEY STACK PENETRATION, AND AT WEST WALL FIREBOX OPENING.
- 4. LIFT THE BUILDING THREE FEET ABOVE THE EXISTING FINISHED FLOOR ELEVATION. REPLACE DETERIORATED FIRST FLOOR WOOD SPANNING ELEMENTS. THE AREA OF REPLACEMENT IS THE SOUTH SECTION OF THE BUILDING AS SHOWN ON THE DRAWINGS.
- . INSTALL NEW CONCRETE GRADE BEAM AND STEM WALL FOUNDATIONS, INCLUDING A NEW RETAINING WALL AND SLAB AT THE REAR OF THE BUILDING. INCLUDE FOUNDATION FOR ALT. 1 PORCH AT THIS TIME. PRIOR TO EXCAVATION, THE CONTRACTOR SHALL HIRE A PROFESSIONAL ARCHAEOLOGIST TO BE PRESENT ON-SITE DURING THE EXCAVATION PROCESS. (SEE SPECIFICATIONS)
- 3. CATALOG, REMOVE AND SALVAGE FOR REINSTALLATION, EXTERIOR WOOD SIDING AT LOCATIONS TO RECEIVE SEISMIC REINFORCING ON WALL SURFACES AND / OR FOR INSPECTION OR REPLACEMENT OF VERTICAL REDWOOD SUB-SHEATHING OR WHERE REMOVED FOR CONSTRUCTION ACCESS. ALL SIDING REMOVAL SHALL BE DONE USING METHODS THAT AVOID DAMAGE TO ORIGINAL FABRIC TO THE MAXIMUM EXTENT FEASIBLE. IF UNAVOIDABLE AND IRREPAIRABLE DAMAGE PREVENTS REINSTALLATION, INSTALL NEW IN-KIND WOOD SIDING TO REPLACE MATERIAL LOST TO DETERIORATION OR UNAVOIDABLY DAMAGED IN REMOVAL FOR SEISMIC WORK. REFASTEN LOOSE SIDING THROUGHOUT. REPLACE DETERIORATED VERTICAL SUB-SHEATHING IN-KIND TO MATCH EXISTING HISTORIC SUB-SHEATHING. INSTALL SEISMIC REINFORCING STRAPS AND SHEAR WALLS AS SHOWN ON THE DRAWINGS.
- REFRAME SOUTH EXTERIOR WALL TO RESTORE BEARING. SHEATH REFRAMED WALL WITH VERTICAL REDWOOD SUB-SHEATHING TO MATCH EXISTING HISTORIC SUB-SHEATHING. REPLACEMENT BOARDS SPAN FROM FIRST FLOOR SILL PLATE TO SECOND FLOOR TOP PLATE. CLAD IN WOOD SIDING TO MATCH EXISTING. COVER AND FLASH NEW WINDOW OPENING IN TEMPORARY EXTERIOR GRADE PLYWOOD CLADDING DESIGN SIMILAR TO EXISTING VENTED
- 3. REFRAME NORTHWEST CORNER PICTURE WINDOWS AT PORCH TO RESTORE BEARING. FRAME OPENINGS BASED ON HISTORIC WINDOW LOCATIONS. SHEATH REFRAMED WALL WITH VERTICAL REDWOOD SUB-SHEATHING TO MATCH EXISTING HISTORIC SUB-SHEATHING. REPLACEMENT BOARDS SPAN FROM FIRST FI OOR SILL PLATE TO SECOND FLOOR TOP PLATE CLAD IN WOOD SIDING TO MATCH EXISTING. COVER AND FLASH NEW WINDOW OPENING IN TEMPORARY EXTERIOR GRADE PLYWOOD CLADDING DESIGN SIMILAR TO EXISTING.
- . REMOVE SCORED REDWOOD WALL CLADDING AT THE ORIGINAL NORTH FACING WALL OF THE MAIN BUILDING AT THE DEMOLISHED BAR ADDITION. INSPECT VERTICAL REDWOOD SUB-SHEATHING, IF REQUIRED REPLACEMENT BOARDS SPAN FROM FIRST FLOOR SILL PLATE TO SECOND FLOOR TOP PLATE. CLAD IN WOOD SIDING TO MATCH EXISTING. COVER AND FLASH NEW WINDOW OR EXISTING DOOR OPENINGS IN TEMPORARY EXTERIOR GRADE PLYWOOD CLADDING DESIGN SIMILAR TO EXISTING.
- D. REPAIR OR REPLACE FASCIA, AND EXTERIOR TRIM. REPLACE EXISTING DOOR AT SOUTHWEST CORNER OF BUILDING WITH TEMPORARY VANDAL RESISTANT DOOR AND LOCKING SYSTEM TO PROVIDE SECURE PRIMARY ACCESS TO BUILDING. PREP. PRIME, AND PAINT ALL EXTERIOR WOOD ELEMENTS.
- . DEMOLISH EXISTING MOTEL STRUCTURE TO THE WEST OF THE INN. PRIOR TO DEMOLITION OR CONSTRUCTION, REMOVE HAZARDOUS MATERIALS PER "LEAD AND ASBESTOS SURVEY REPORT" IN MOTEL STRUCTURE AT INN AS SPECIFIED BY RGA ENVIRONMENTAL JULY 31, 2009.

ALTERNATE ONE: RECONSTRUCT THE FRONT PORCH PER 1930'S ERA HISTORIC PHOTOGRAPHS AND AS SHOWN IN THE DRAWINGS. ALTERNATE TWO: DEMOLISH TEMPORARY ROOF AND OLD ROOFING - INSTALL NEW PLYWOOD SHEATHING OVER (E) SKIP SHEATHING. INSTALL NEW ASPHALT SHINGLE ROOF. ALTERNATE THREE: INSTALL TEMPORARY WINDOWS AT SPECIFIED LOCATIONS ON FIRST FLOOR.

HISTORICAL STATUS: LISTING ON NATIONAL REGISTER OF HISTORIC PLACES - PENDING

APPLICABLE CODES AND GUIDELINES: CALIFORNIA BUILDING CODE (2007) AND STATE HISTORICAL BUILDING CODE (2007)

CONSTRUCTION TYPE: ARCHAIC, WOOD FRAME TYPE V

<u>ARCHTECTURAL</u>

AO.O COVER SHEET

A2.2 PLAN - ROOF

A3.0 ELEVATION - NORTH

A3.1 ELEVATION - SOUTH

A4.0 SECTION - N-S

A7.0 BASE BID DETAILS

A7.1 BASE BID DETAILS

A7.2 ALT. 1 DETAILS - PORCH

ALT. 3 DETALS - WINDOWS

A7.3 ALT. 2 DETAILS - ROOF

A3.2 ELEVATION - EAST & WEST

AO.1 SITE PLAN

OCCUPANCY: THIS PROJECT IS FOR STABILIZATION ONLY. NO OCCUPANCY WILL OCCUR AT PROJECT COMPLETION.

GROSS AREA: 1ST FLOOR: 1263 SQ FT 2ND FLOOR: 1219 SQ SF

A1.2 DECONSTRUCTION PLAN - ROOF A1.3 DECONSTRUCTION PLAN - HOTEL

A2.1 PLAN - FIRST FL & SECOND FL

LIST OF DRAWINGS

A1.1a DECONSTRUCTION PLAN - 2nd FL S1.3 ROOF FRAMING PLAN

STRUCTURAL

S2.1 ELEVATIONS

A1.1 DECONSTRUCTION PLAN - 1st FL S1.2 SECOND FLOOR FRAMING PLAN

S1.1 FOUNDATION & 1ST FLR FRAMING

S3.1 TYP FOUNDATION DETAILS

S4.1 TYPICAL FRAMING DETAILS I

S4.2 TYPICAL FRAMING DETAILS II

S5.1 LATERAL FRAMING DETAILS

S3.2 FOUNDATION DETAILS

8-10-09 12-14-09 REVISED 100% CD SET 2-15-10 REVISED 100% CD SET BID DOCUMENTS 05-16-11 SO.1 GENERAL NOTES

STAMP:

COVER

DATE:	8-10-09
DRAWN:	C.M.
CHECKED:	C.D.
PROJECT NO.:	26183
SCALE:	AS NOTED

DRAWING NO.:

□ FULL-SIZE, 22x34



☐ HALF-SIZE, 11x17

CONSULTANT:

CLIENTS:

Navarro-by-the-Sea Center for Riparian and Estuarine Research (NSCR)

Mendocino, CA 95460

Mendocino, CA 95460

Old Engine Co. No. 2

460 Bush Street

San Francisco, CA 94108

415.773.0773 f. 415.773.1773

P.O. Box 1710

707-877-3477

CA State Parks Mendocino District, Headquarters

Highway 1

707-937-5804

ARCHITECT:

AVARRO

11-12-08


CAREY & CO. INC.

75% PROGRESS PRINTING SET 12-19-08 100% C.D. SET

PROGRESS PRINTING SET

DRAWING TITLE:

SHEET

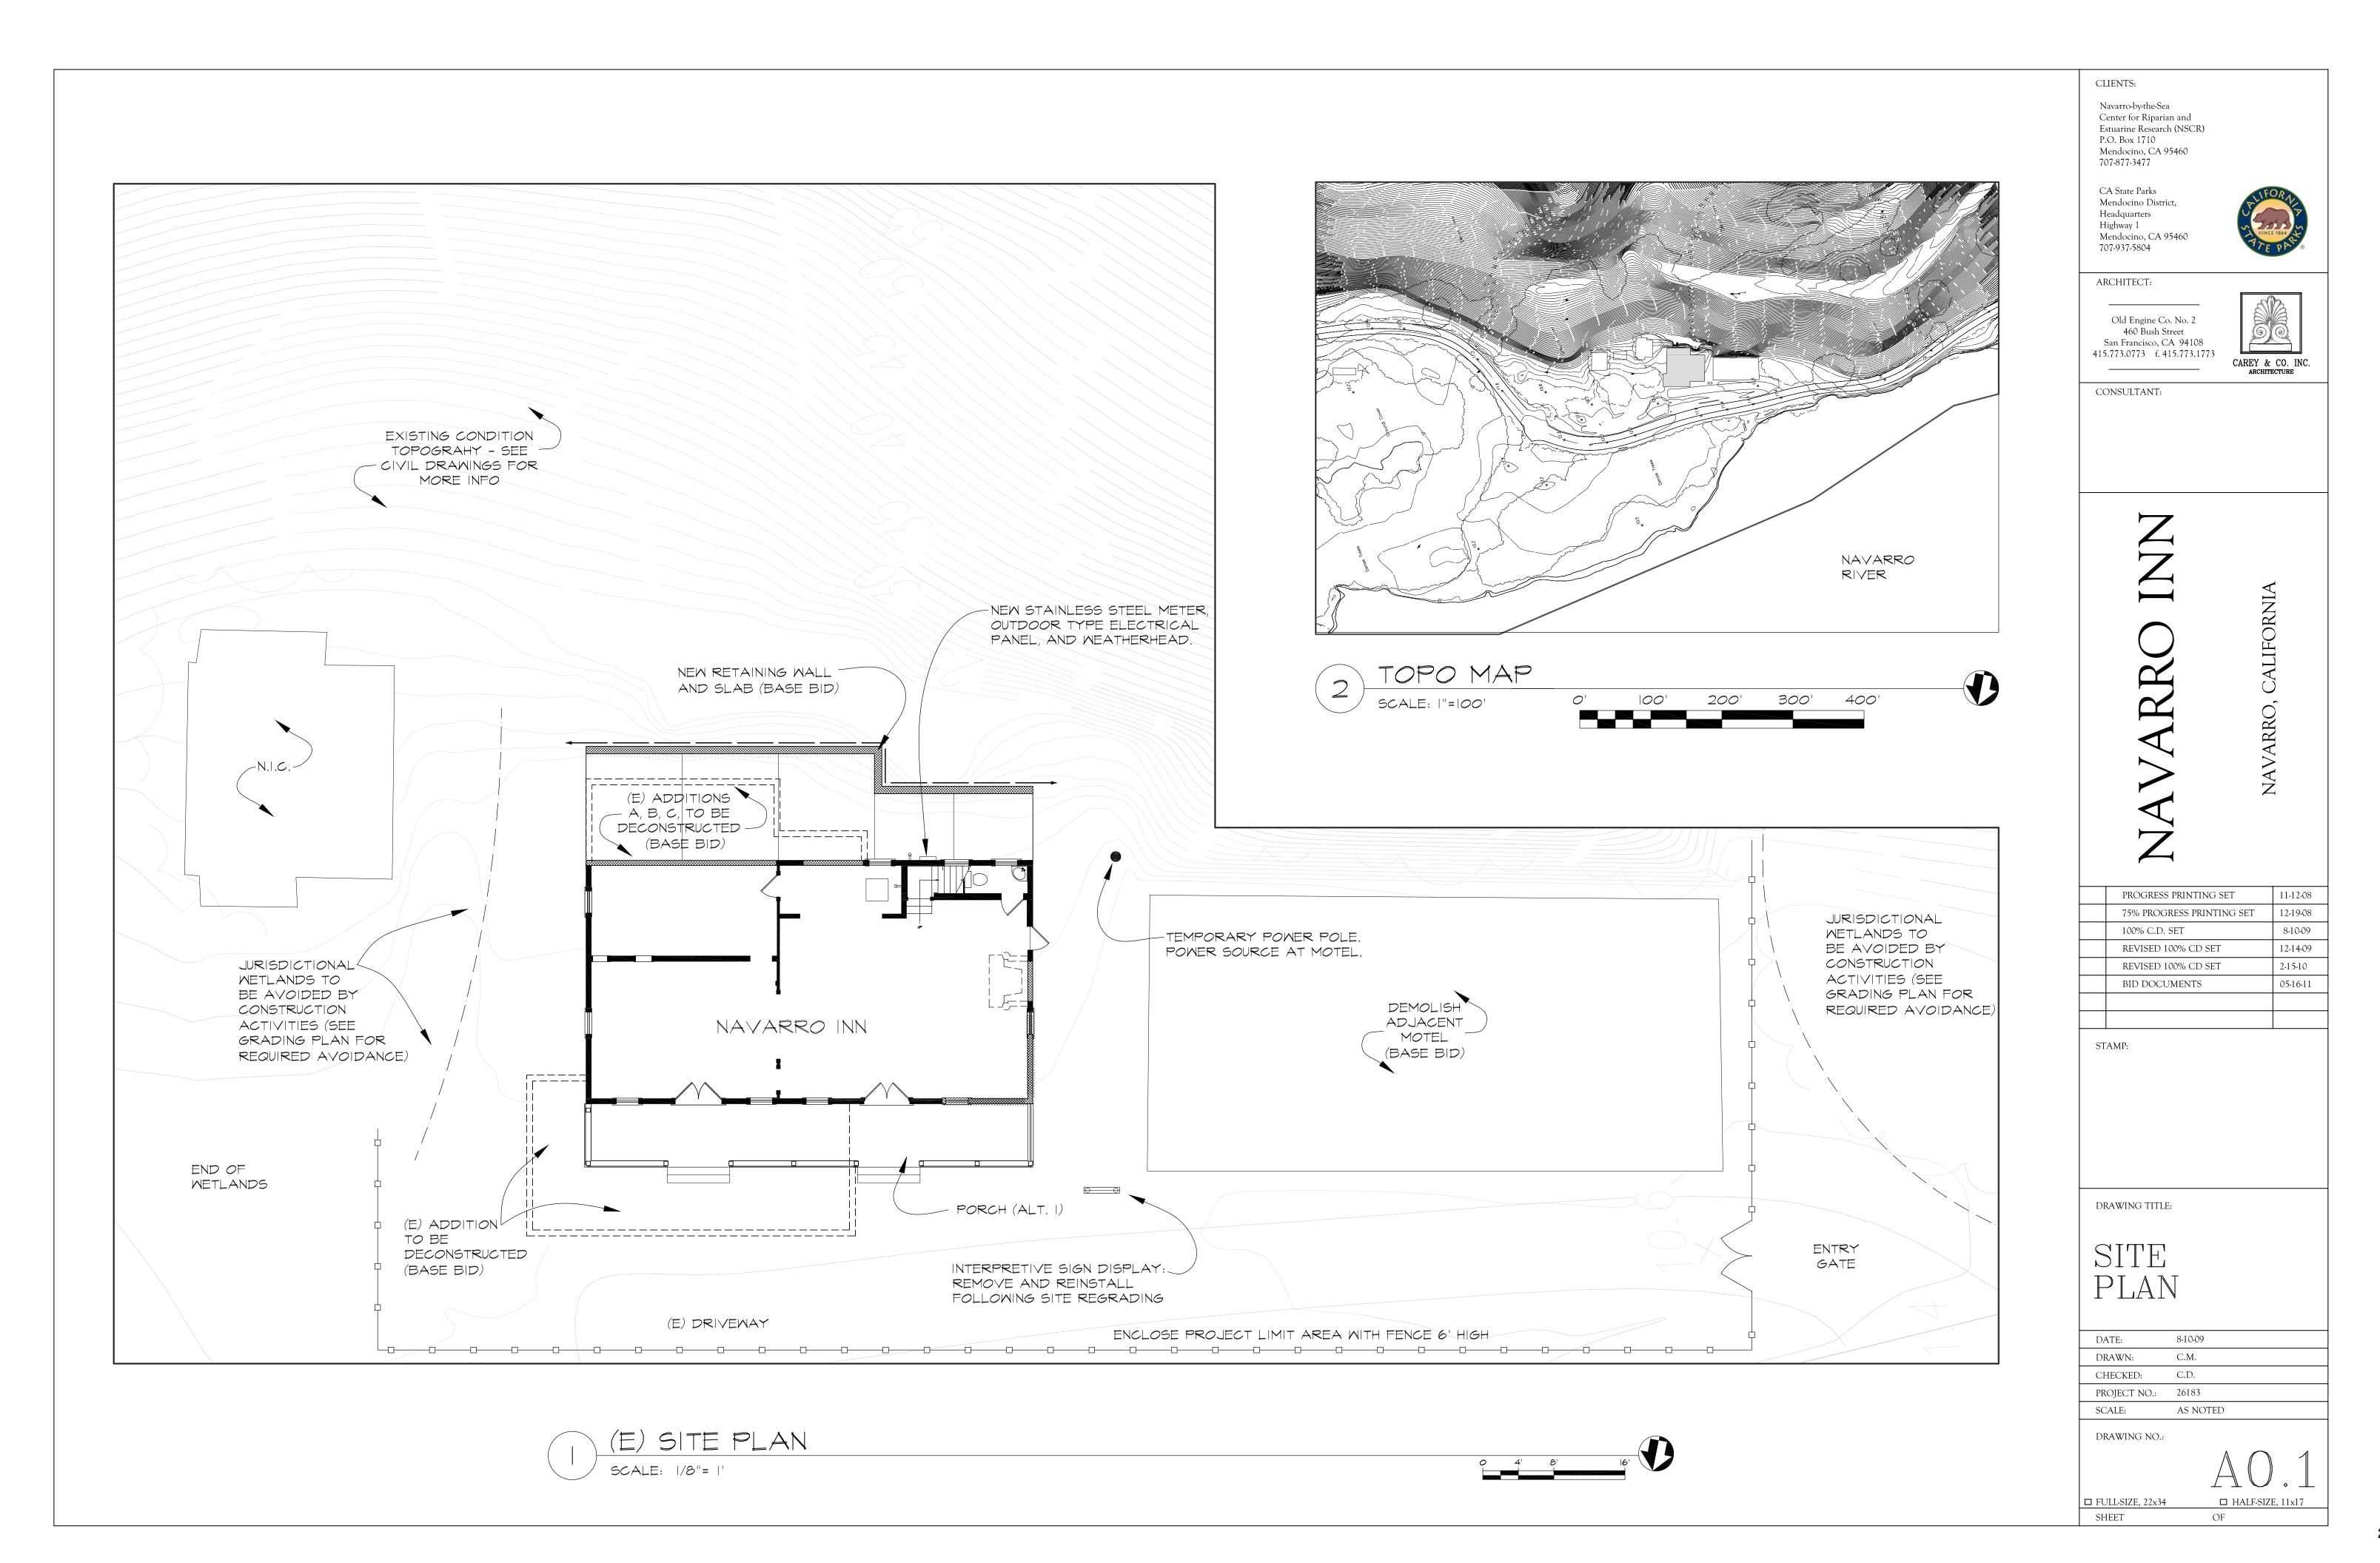

ADDITION C ADDITION B ADDITION A 103 104 (5)— $|\mathcal{O}|$ PORCH FIRST FLOOR

DECONSTRUCTION PLAN - FIRST FLOOR

SCALE: 1/4"=1'-0"

KEY NOTES

CLADDING.

- REMOVE REAR ADDITIONS. PHOTODOCUMENT THE INTERIOR AND EXTERIOR OF ADDITION B. DOCUMENT ADEQUATELY FOR REBUILDING, INCLUDING MEASURED DRAWINGS, IN A FUTURE PHASE. RETAIN ALL USEABLE ELEMENTS FOR FUTURE USE AND STORE IN BUILDING OR AS DIRECTED BY STATE REPRESENTATIVE. ASSUME 100% RETENTION OF ADDITION B ELEMENTS INCLUDING INTERIOR SHEATHING, CALIFORNIA COOLER AND EXTERIOR
- (2) REMOVE PICTURE WINDOWS.
- (3) REMOVE PORCH ADDITION. REMOVAL INCLUDES PLUMBING, FXTURES, AND BAR. PRIOR TO DEMOLITION REMOVE ASBESTOS AND LEAD CONTAINING MATERIALS. SEE SPECIFICATIONS.
- (4) DECONSTRUCT CHIMNEY STACK, FIREBOX, MANTLE, AND FIREPLACE SURROUND ELEMENTS. SALVAGE BRICKS AND STORE IN WORKSHOP BUILDING ACROSS FROM MILL HOUSE FOR RE-INSTALLATION IN A FUTURE PHASE. STACK BRICKS ON PALLETS AT A SUFFICIENT HEIGHT TO PROTECT AGAINST FLOOD EVENTS. RETAIN ALL ELEMENTS OF CHIMNEY ASSEMBLY FOR RECONSTRUCTION. DOCUMENT ANY EVIDENCE OF EARLIER FIREPLACE/CHIMNEY CONSTRUCTION.
- (5) RETAIN PINE INTERIOR WALL CLADING THROUGHOUT FIRST FLOOR.
- (6) REMOVE EXISTING PORCH. SALVAGE THREE 6X6 POSTS AND RAIL CAP FOR RE-USE. SLAVAGE SIDING. PHOTODOCUMENT PORCH PRIOR TO REMOVAL AND DOCUMENT ADEQUATELY FOR REBUILDING AS SHOWN IN ALTERNATE #1.
- (7) REMOVE SCORED REDWOOD MALL CLADDING AT THE ORIGINAL NORTH FACING WALL OF THE MAIN BUILDING AT THE DEMOLISHED BAR ADDITION TO EXPOSE ORIGINAL EXTERIOR MALL.
- 8) ROOM 104: REMOVE DETERIORATED FIRST FLOOR WOOD SPANNING ELEMENTS AND FLOORING.
- (9) DEMOLISH BURIED RETAINING MALL AT HILLSIDE.

GENERAL NOTES

- REMOVE AND DISPOSE OF STOVE IN ROOM 104. RETAIN AND PROTECT HISTORIC ELEMENTS INCLUDING BUT NOT LIMITED TO THE BAR, COOLER, AND FIXTURES IN DOWNSTAIRS BATH. REMOVE AND SALVAGE FOR
- REINSTALLATION, EXTERIOR SIDING AT LOCATIONS TO RECEIVE SEISMIC REINFORCING ON WALL SURFACES AND/OR FOR INSPECTION OR REPLACEMENT OF VERTICAL REDWOOD SUB-SHEATHING, OR WHERE REMOVED FOR GENERAL CONSTRUCTION ACCESS.

CLIENTS:

Navarro-by-the-Sea Center for Riparian and Estuarine Research (NSCR) P.O. Box 1710 Mendocino, CA 95460 707-877-3477

CA State Parks Mendocino District, Headquarters Highway 1 Mendocino, CA 95460 707-937-5804



ARCHITECT:

Old Engine Co. No. 2 460 Bush Street San Francisco, CA 94108 415.773.0773 f. 415.773.1773



CONSULTANT:

PROGRESS PRINTING SET	11-12-08
75% PROGRESS PRINTING SET	12-19-08
100% C.D. SET	8-10-09
REVISED 100% CD SET	12-14-09
REVISED 100% CD SET	2-15-10
BID DOCUMENTS	05-16-11
	-

DRAWING TITLE:

LEGEND

TO BE DECONSTRUCTED

DECON PLAN 1ST FLOOR

DATE:	8-10-09
DRAWN:	C.M.
CHECKED:	C.D.
PROJECT NO.:	26183
SCALE:	AS NOTED

DRAWING NO.:

☐ HALF-SIZE, 11x17

208 206 204 202 213

SECOND FLOOR

GENERAL NOTES

I. REMOVE AND SALVAGE FOR REINSTALLATION, EXTERIOR SIDING AT LOCATIONS TO RECEIVE SEISMIC REINFORCING ON WALL SURFACES AND/OR FOR INSPECTION OR REPLACEMENT OF VERTICAL REDWOOD SUB-SHEATHING, OR WHERE REMOVED FOR GENERAL CONSTRUCTION ACCESS.

CLIENTS:

Navarro-by-the-Sea Center for Riparian and Estuarine Research (NSCR) P.O. Box 1710 Mendocino, CA 95460 707-877-3477

CA State Parks Mendocino District, Headquarters Highway 1 Mendocino, CA 95460 707-937-5804



ARCHITECT:

Old Engine Co. No. 2 460 Bush Street San Francisco, CA 94108 415.773.0773 f. 415.773.1773



CONSULTANT:

KEY NOTES

- I) DECONSTRUCT CHIMNEY STACK, FIREBOX, MANTLE, AND FIREPLACE SURROUND ELEMENTS. SALVAGE BRICKS AND STORE IN WORKSHOP BUILDING ACROSS FROM MILL HOUSE FOR RE-INSTALLATION IN A FUTURE PHASE. STACK BRICKS ON PALLETS AT A SUFFICIENT HEIGHT TO PROTECT AGAINST FLOOD EVENTS. RETAIN ALL ELEMENTS OF CHIMNEY ASSEMBLY FOR RECONSTRUCTION. DOCUMENT ANY EVIDENCE OF EARLIER FIREPLACE/CHIMNEY CONSTRUCTION.
- 2 REMOVE AND DISPOSE OF FIXTURES IN ROOM 213 AND DEMOLISH WALLS FACING HALLWAY TO EXPOSE ORIGINAL WALL TO ROOM 202 AND DEMOLISH RAISED FLOOR TO EXPOSE ORIGINAL FLOORING.

VARRO IN

NAVARRO, CALIFORNI

PROGRESS PRINTING SET	11-12-08
75% PROGRESS PRINTING SET	12-19-08
100% C.D. SET	8-10-09
REVISED 100% CD SET	12-14-09
REVISED 100% CD SET	2-15-10
BID DOCUMENTS	05-16-11

STAME

DRAWING TITLE:

LEGEND

TO BE DEMOLISHED

DECON PLAN 2ND FLOOR

DATE:	8-10-09
DRAWN:	C.M.
CHECKED:	C.D.
PROJECT NO.:	26183
SCALE:	AS NOTED

DRAWING NO.:


☐ FULL-SIZE, 22x34 ☐ HALF-SIZE, 11x1

OF

DECONSTRUCTION PLAN - SECOND FLOOR

SCALE: 1/4"=1'-0"



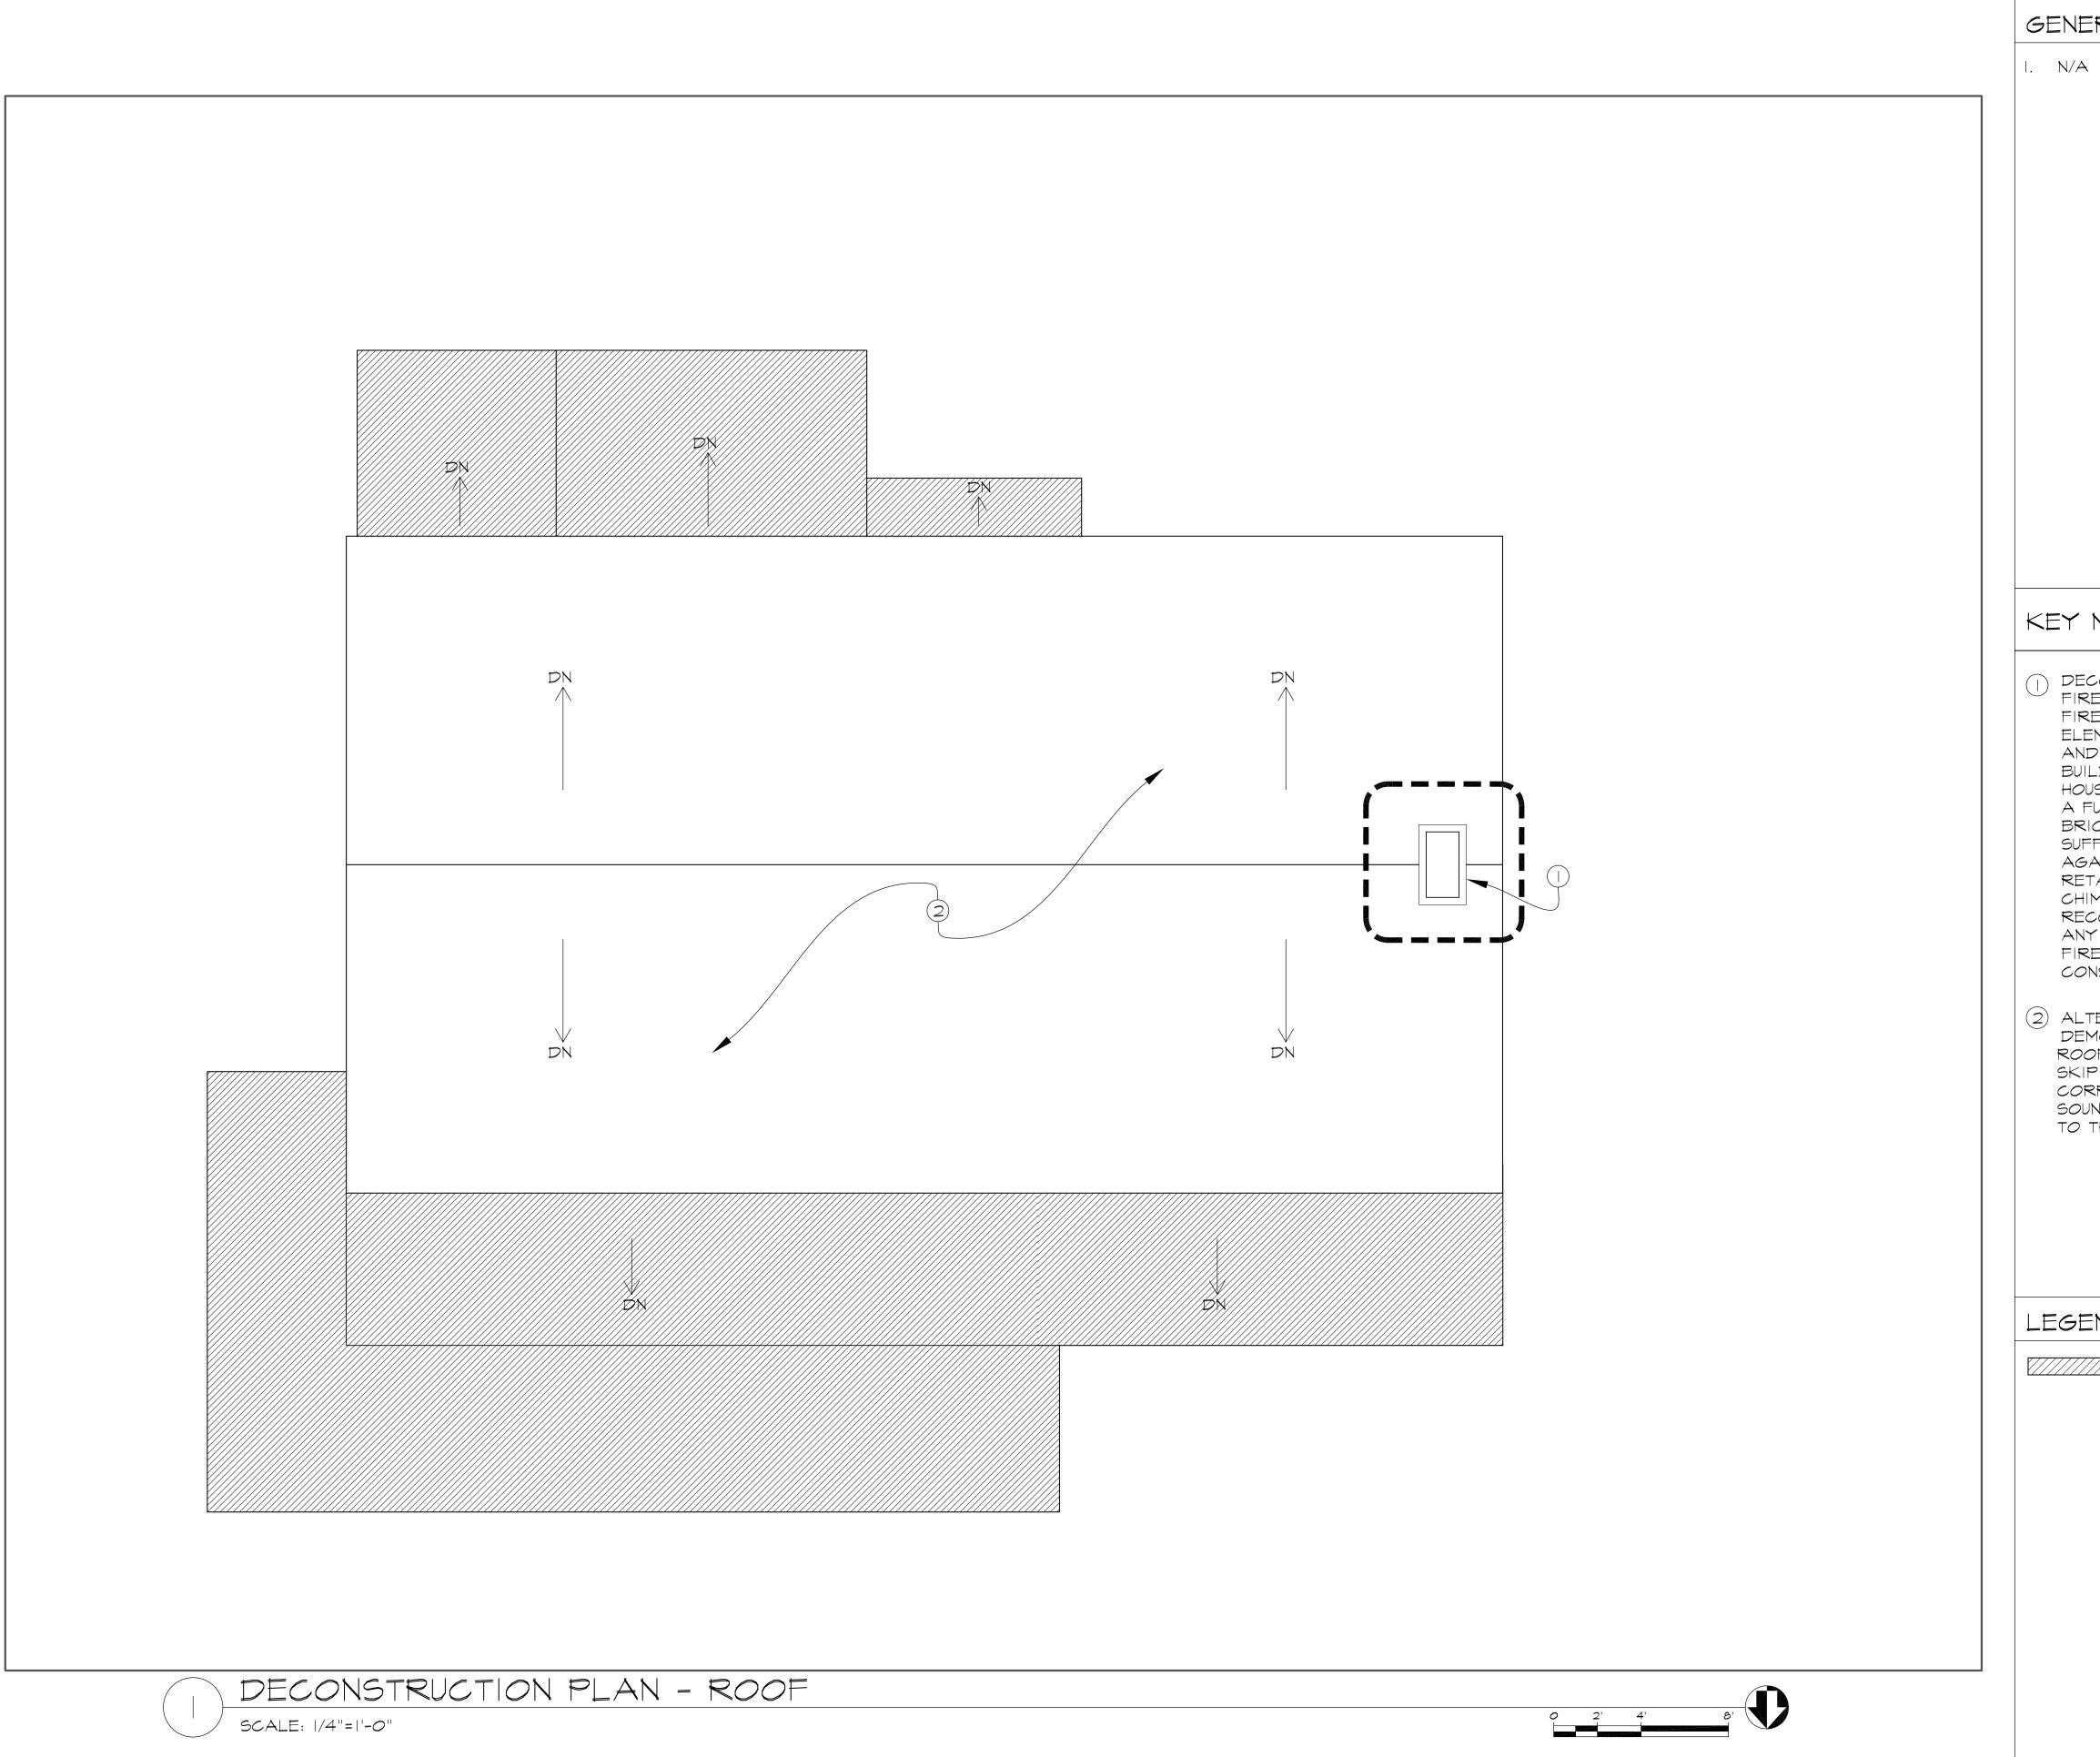

GENERAL NOTES

CLIENTS:

Navarro-by-the-Sea Center for Riparian and Estuarine Research (NSCR) P.O. Box 1710 Mendocino, CA 95460 707-877-3477

CA State Parks Mendocino District, Headquarters Highway 1 Mendocino, CA 95460 707-937-5804



ARCHITECT:

Old Engine Co. No. 2 460 Bush Street San Francisco, CA 94108 415.773.0773 f. 415.773.1773



CONSULTANT:

KEY NOTES

DECONSTRUCT CHIMNEY STACK, FIREBOX, MANTLE, AND FIREPLACE SURROUND ELEMENTS. SALVAGE BRICKS AND STORE IN WORKSHOP BUILDING ACROSS FROM MILL HOUSE FOR RE-INSTALLATION IN A FUTURE PHASE. STACK BRICKS ON PALLETS AT A SUFFICIENT HEIGHT TO PROTECT AGAINST FLOOD EVENTS. RETAIN ALL ELEMENTS OF CHIMNEY ASSEMBLY FOR RECONSTRUCTION. DOCUMENT ANY EVIDENCE OF EARLIER FIREPLACE/CHIMNEY CONSTRUCTION.

2 ALTERNATE TWO: DEMOLISH TEMPORARY METAL ROOF AND OLD ROOFING TO THE SKIP SHEATHING. IF TEMPORARY CORRUGATED ROOF SHEETS ARE SOUND, SALVAGE FOR DELIVERY TO THE STATE REPRESENTATIVE.

PROGRESS PRINTING SET	11-12-08
75% PROGRESS PRINTING SET	12-19-08
100% C.D. SET	8-10-09
REVISED 100% CD SET	12-14-09
REVISED 100% CD SET	2-15-10
BID DOCUMENTS	05-16-11
_	
	-

LEGEND

TO BE DEMOLISHED

DRAWING TITLE:


DECON PLAN ROOF

DATE:	8-10-09
DRAWN:	C.M.
CHECKED:	C.D.
PROJECT NO.:	26183
SCALE:	AS NOTED

DRAWING NO.:




☐ FULL-SIZE, 22x34

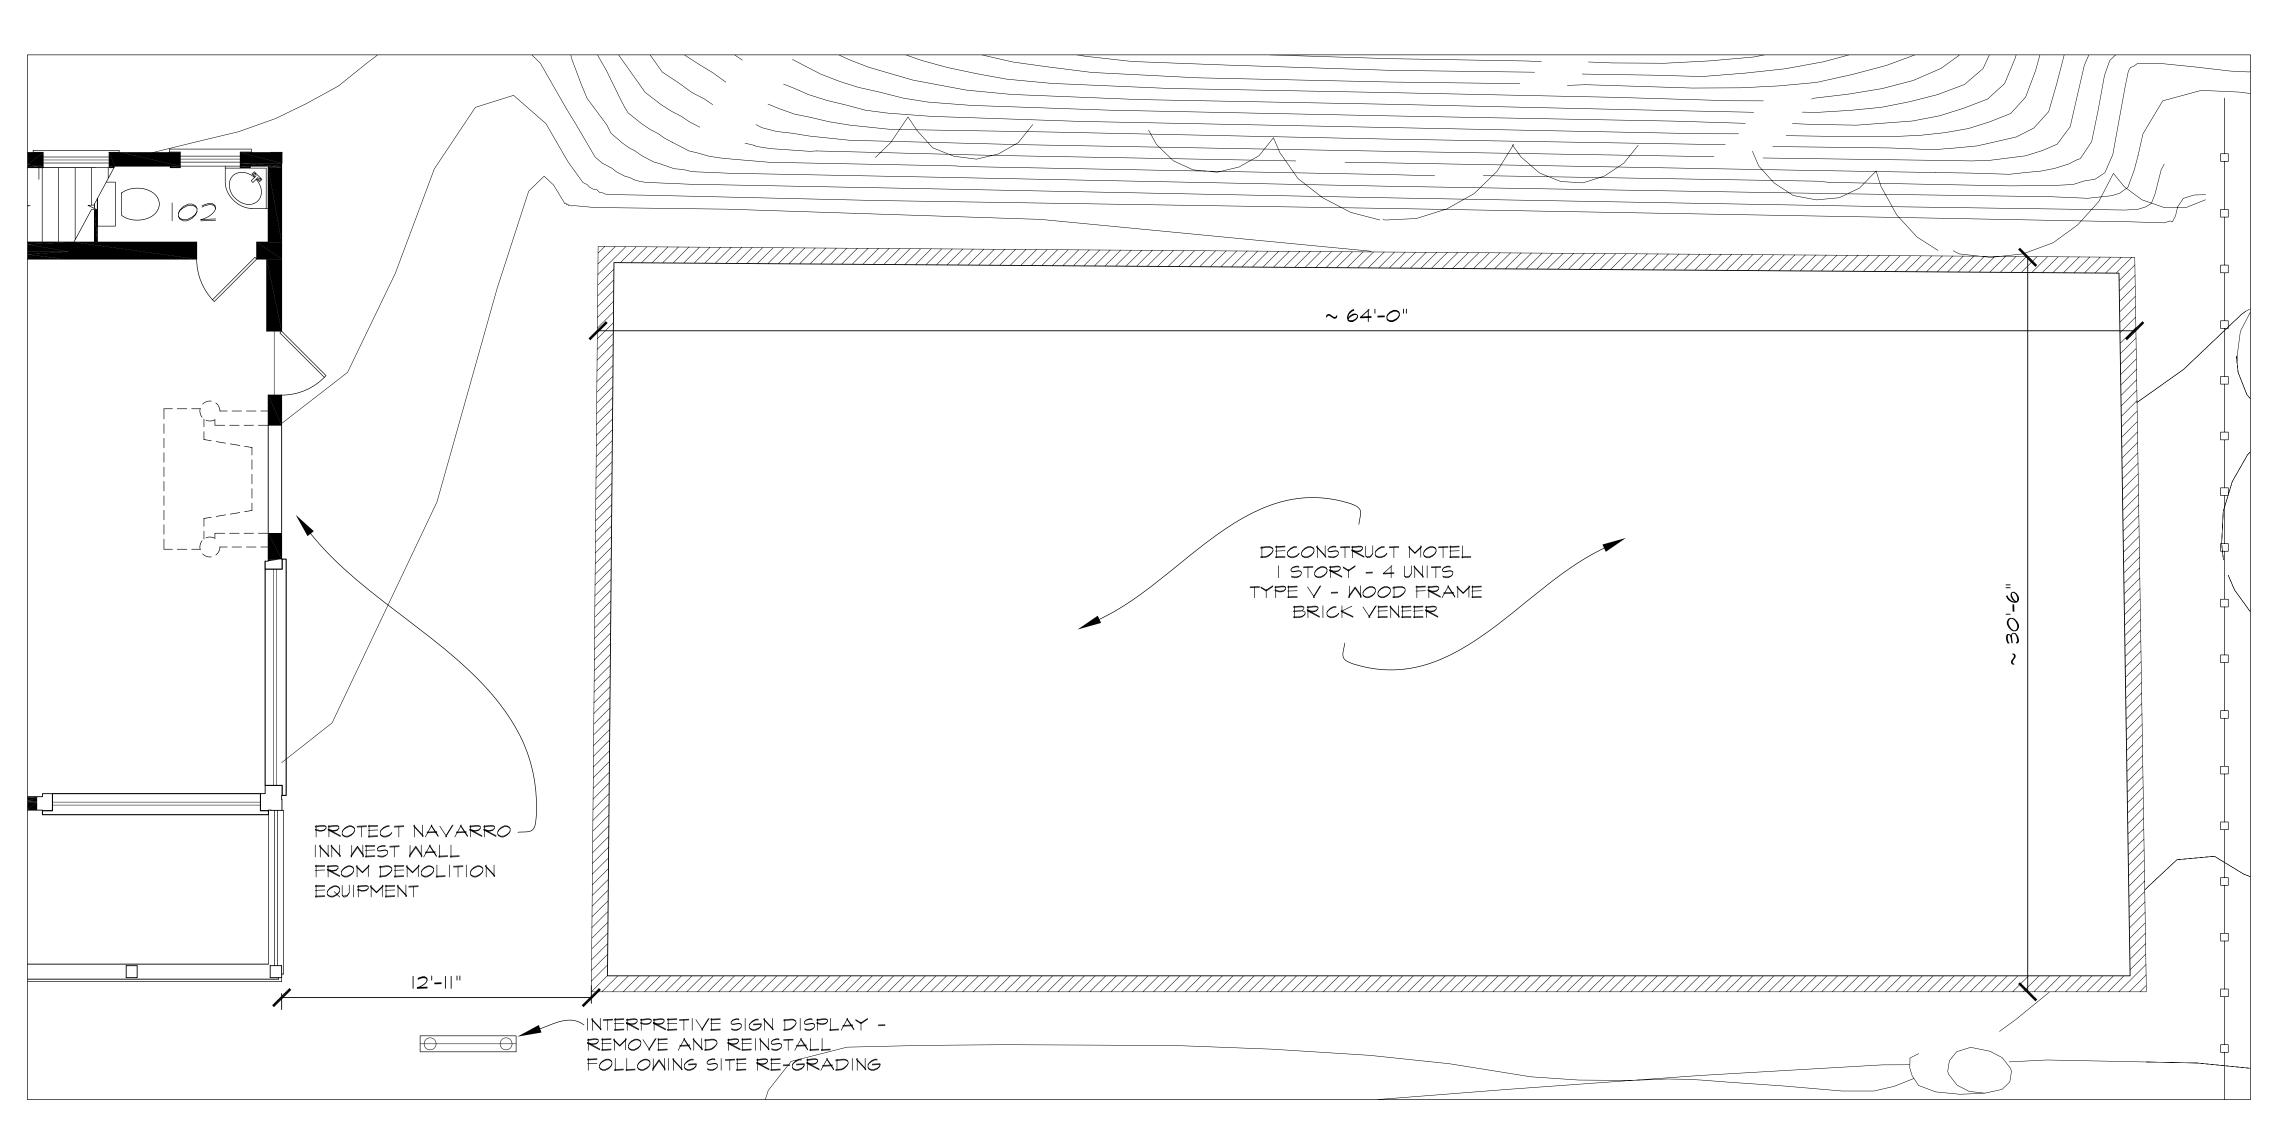

DECONSTRUCTION PLAN - MOTEL SCALE: 1/4"=1'-0"



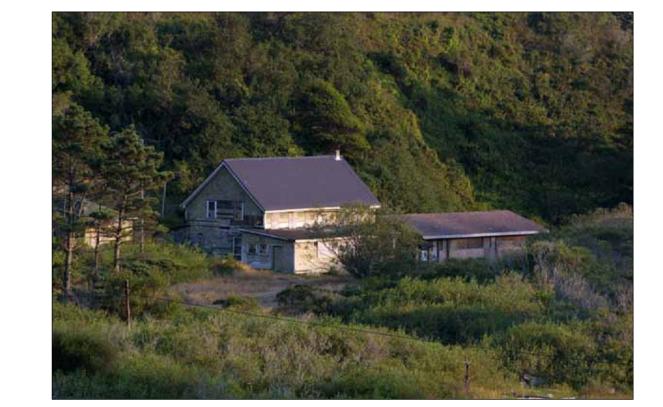



MOTEL PHOTOGRAPHS SCALE: NO SCALE

GENERAL NOTES

KEY NOTES

LEGEND

SEE SPECIFICATION BUILDING DECONSTRUCTION FOR DECONSTRUCTION REQUIREMENTS. PRIOR TO DECONSTRUCTION REMOVE LEAD AND ASBESTOS CONTAINING MATERIALS. SEE SPECIFICATIONS.

2. REMOVE INTERPRETIVE SIGN DISPLAY TO PREVENT DAMAGE DURING CONSTRUCTION AND REINSTALL FOLLOWING

COMPLETION OF SITE GRADING.

CLIENTS: Navarro-by-the-Sea

Center for Riparian and Estuarine Research (NSCR) P.O. Box 1710 Mendocino, CA 95460 707-877-3477

CA State Parks Mendocino District, Headquarters Highway 1 Mendocino, CA 95460 707-937-5804



ARCHITECT:

Old Engine Co. No. 2 460 Bush Street San Francisco, CA 94108 415.773.0773 f. 415.773.1773



CONSULTANT:

PROGRESS PRINTING SET 11-12-08 75% PROGRESS PRINTING SET 12-19-08 100% C.D. SET 8-10-09 REVISED 100% CD SET 12-14-09 REVISED 100% CD SET 2-15-10 BID DOCUMENTS 05-16-11		
100% C.D. SET 8-10-09 REVISED 100% CD SET 12-14-09 REVISED 100% CD SET 2-15-10	PROGRESS PRINTING SET	11-12-08
REVISED 100% CD SET 12-14-09 REVISED 100% CD SET 2-15-10	75% PROGRESS PRINTING SET	12-19-08
REVISED 100% CD SET 2-15-10	100% C.D. SET	8-10-09
	REVISED 100% CD SET	12-14-09
BID DOCUMENTS 05-16-11	REVISED 100% CD SET	2-15-10
	BID DOCUMENTS	05-16-11

DECON PLAN TO BE DEMOLISHED MOTEL


DRAWING TITLE:

DATE:	8-10-09
DRAWN:	C.M.
CHECKED:	C.D.
PROJECT NO.:	26183
SCALE:	AS NOTED



DRAWING NO.:

☐ FULL-SIZE, 22x34

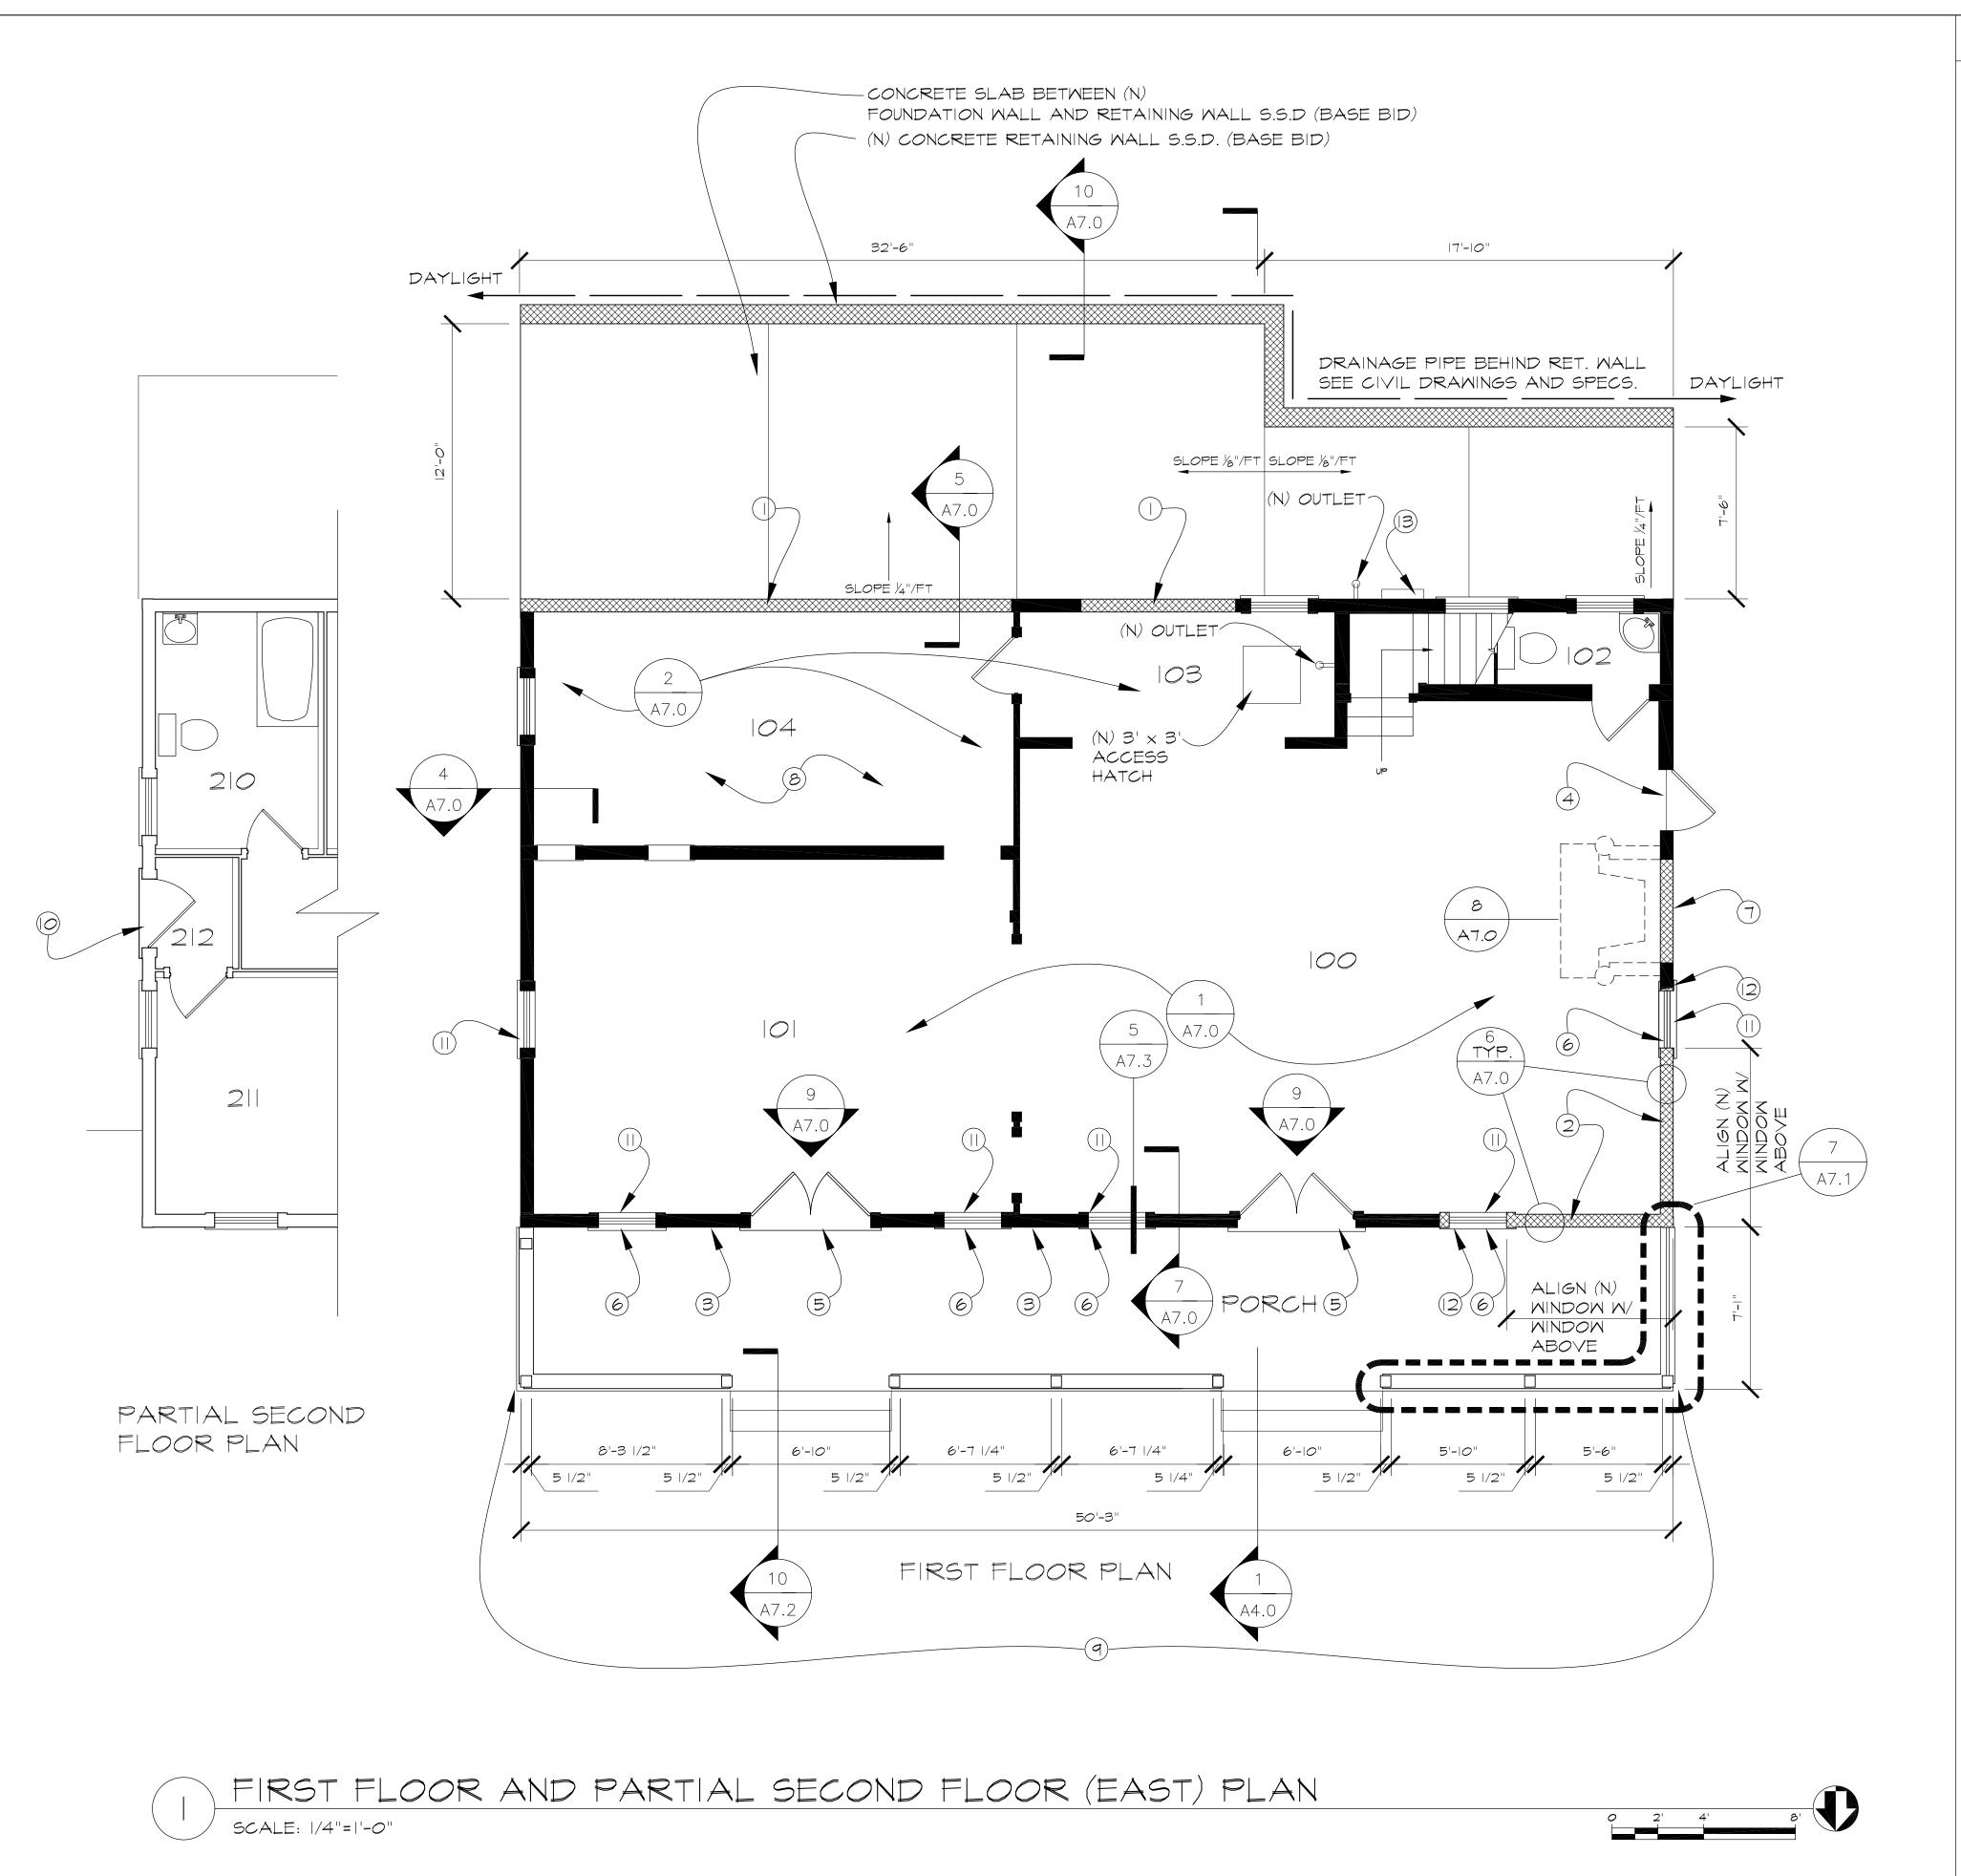

KEY NOTES

- REFRAME SOUTH EXTERIOR WALL TO RESTORE BEARING. SHEATH REFRAMED WALL WITH VERTICAL REDWOOD SUB-SHEATHING TO MATCH EXISTING HISTORIC SUB-SHEATHING. REPLACEMENT BOARDS SPAN FROM FIRST FLOOR SILL PLATE TO SECOND FLOOR TOP PLATE. CLAD IN WOOD SIDING TO MATCH EXISTING. S.S.D. OR EXISTING.
- (2) REFRAME NORTHWEST CORNER PICTURE WINDOWS AT PORCH TO RESTORE BEARING. ROUGH FRAME OPENINGS BASED ON HISTORIC WINDOW LOCATIONS AND DIMENSIONS. SHEATH REFRAMED WALL WITH VERTICAL REDWOOD SUB-SHEATHING TO MATCH EXISTING HISTORIC SUB-SHEATHING. REPLACEMENT BOARDS SPAN FROM FIRST FLOOR SILL PLATE TO SECOND FLOOR TOP PLATE. CLAD IN DROP SIDING TO MATCH EXISTING. S.S.D.
- |(3) inspect vertical redwood SUB-SHEATHING. IF REQUIRED REPLACEMENT BOARDS SPAN FROM FIRST FLOOR SILL PLATE TO SECOND FLOOR TOP PLATE, CLAD WITH WOOD SIDING TO MATCH EXISTING.
- (4) REPLACE EXISTING DOOR AT SOUTHWESTERN CORNER OF BUILDING WITH A TEMPORARY SOLID WOOD CORE EXTERIOR GRADE, VANDAL RESISTANT DOOR AND LOCKING SYSTEM TO PROVIDE SECURE, PRIMARY ACCESS TO BUILDING. SLAVAGE AND STORE EXISTING DOOR FOR RE-USE.
- (5) CLOSE AND SECURE EXISTING DOUBLE DOORS. MOUNT PLYWOOD PROTECTION ON EXTERIOR SIMILAR TO EXISTING MINDOM PROTECTION. (SEE DET. 3/A7.0) SECURE DOORS FROM INTERIOR (SEE DET. 9/A7.0)
- (6) COVER AND FLASH NEW MINDOM OPENING IN TEMPORARY EXTEROIR GRADE PLYWOOD CLADDING DESIGN SIMILAR TO EXISTING WINDOW PROTECTION. (BASE
- (7) FIREBOX REMOVAL WILL LEAVE A GAP IN THE WEST WALL. INSTALL TEMPORARY FRAMING TO RESTORE BEARING. CLAD OPENING WITH PLYWOOD SHEATHING AND NEW REDWOOD SIDING TO MATCH EXISTING.
- (8) ROOM 104: REFRAME DETERIORATED FLOOR JOISTS. INSTALL PLYMOOD SUB-FLOORING. TOP OF PLYWOOD SUBFLOOR TO MATCH TOP OF EXISTING SUBFLOOR. FINISHED FLOOR INSTALL IN A FUTURE PHASE. COORDINATE WITH STRUCTURAL DRAWINGS.

- (9) ALTERNATE ONE: RECONSTRUCT THE FRONT PORCH PER 1930'S ERA HISTORIC PHOTOGRAPHS AND AS SHOWN IN THE DRAWINGS. REPAIR AND / OR REPLACE THE MOOD SIDING.
- CLOSE EXISTING DOOR AND REPAIR/REPLACE EXISTING EXTERIOR WOOD CLADDING COVERING DOOR.
- ALTERNATE 3 INSTALL TEMPORARY DOUBLE-HUNG MOOD MINDOM. FIELD VERIFY R.O. DIMENSIONS AND UNIT SIZE BEFORE ORDERING.
- (12) ALIGN HEAD OF (N) WINDOW WITH HEAD OF (E) IST FLR MINDOWS. ALIGN JAMB OF (N) WINDOWS WITH JAMB OF (E) 2ND FLR WINDOW.
- RELOCATE EXISTING POWER LINE FROM MOTEL TO SOUTHWEST CORNER OF INN. RECONNECT TO (N) STAINLESS STEEL OUTDOOR TYPE ELECTRICAL PANEL, METER AND WEATHERHEAD SUITABLE FOR MARINE ENVIRONMENT.

GENERAL NOTES

- SEE STRUCTURAL DRAWINGS FOR SEISMIC RETROFIT AND FRAMING INFORMATION.
- 2. LIFT THE BUILDING THREE FEET ABOVE THE FINISHED FLOOR ELEVATION. S.S.D.
- 3. PREP, PRIME AND PAINT ALL EXTEROIR WOOD ELEMENTS. SEE SPECS.

CLIENTS:

Navarro-by-the-Sea Center for Riparian and Estuarine Research (NSCR) P.O. Box 1710 Mendocino, CA 95460 707-877-3477

CA State Parks Mendocino District, Headquarters Highway 1 Mendocino, CA 95460 707-937-5804



ARCHITECT:

Old Engine Co. No. 2 460 Bush Street San Francisco, CA 94108 415.773.0773 f. 415.773.1773



CONSULTANT:

	PROGRESS PRINTING SET	11-12-0
	75% PROGRESS PRINTING SET	12-19-0
	100% C.D. SET	8-10-0
	REVISED 100% CD SET	12-14-0
	REVISED 100% CD SET	2-15-10
	BID DOCUMENTS	05-16-1
STAMP.		

LEGEND

EXISTING WALL

NEW MALL

FLOOR

PLAN

DRAWING TITLE:

DATE: 8-10-09 DRAWN: C.M. CHECKED: C.D. PROJECT NO.: 26183

AS NOTED


OF

□ FULL-SIZE, 22x34

SCALE:

DRAWING NO.:

☐ HALF-SIZE, 11x17

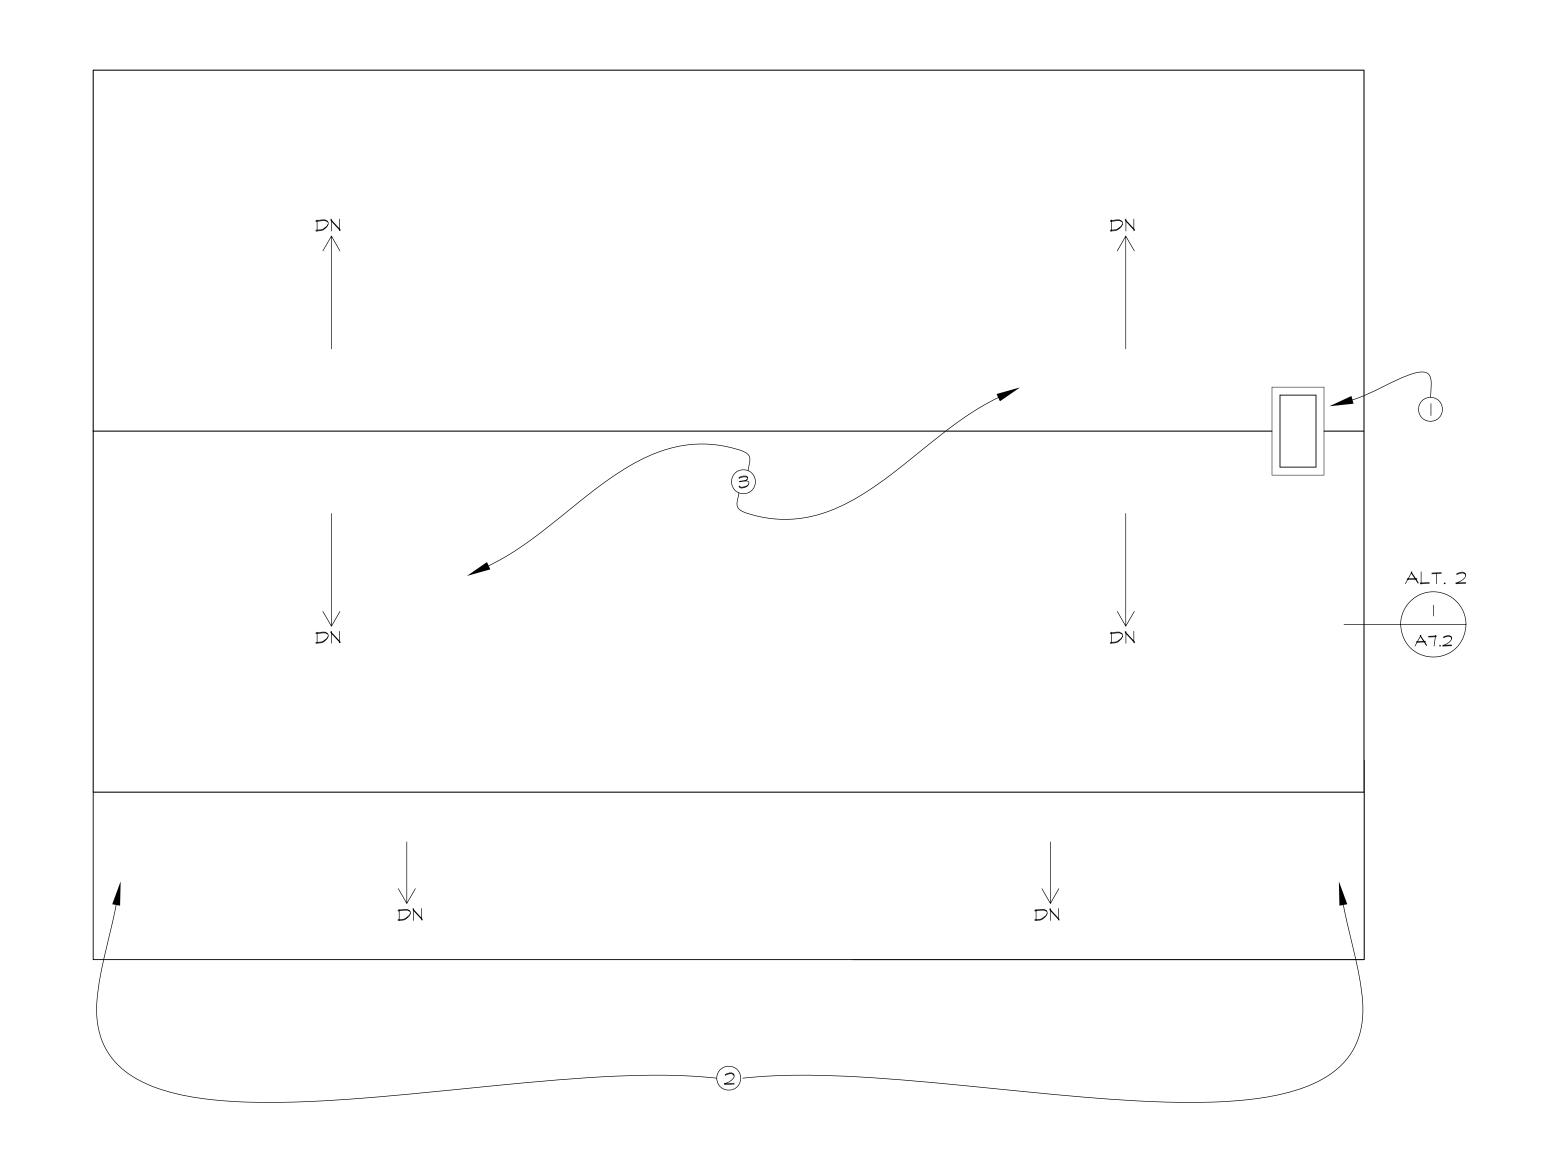



I. N/A

CLIENTS:

Navarro-by-the-Sea Center for Riparian and Estuarine Research (NSCR) P.O. Box 1710 Mendocino, CA 95460 707-877-3477

CA State Parks Mendocino District, Headquarters Highway 1 Mendocino, CA 95460 707-937-5804



ARCHITECT:

Old Engine Co. No. 2 460 Bush Street San Francisco, CA 94108 415.773.0773 f. 415.773.1773



CONSULTANT:

KEY NOTES

- (I) BASE BID: PATCH OPENING LEFT BY CHIMNEY STACK REMOVAL. CLOSE HEADED OPENING WITH TEMPORARY 2X4 FRAMING. ATTACH NEW TEMPORARY PLYWOOD SHEATHING AND COVER WITH CORRUGATED SHEET METAL ROOFING TO MATCH EXISTING. ATTACH SHEET METAL RIDGE FLASHING AND LAP OVER EXISTING RIDGE.
- 2 ALTERNATE ONE: RECONSTRUCT FRONT PORCH PER 1930s ERA HISTORIC PHOTOGRAPHS AND AS SHOWN IN THE DRAWINGS. REPAIR AND/OR REPLACE THE WOOD SIDING IN THE FRONT (NORTH) ELEVATION.
- 3 ALTERNATE TWO: REMOVE EXISTING ROOF AND REPLACE DETERIORATED JOISTS. INSTALL NEW PLYWOOD SHEATHING. INSTALL NEW ASPHALT SHINGLE ROOF. S.S.D.

כ	PROGRESS PRINTING SET	11-12-08
?	75% PROGRESS PRINTING SET	12-19-08
	100% C.D. SET	8-10-09
	REVISED 100% CD SET	12-14-09
	REVISED 100% CD SET	2-15-10
	BID DOCUMENTS	05-16-11

LEGEND

DRAWING TITLE:

ROOF PLAN INCLUDES ALT. #1


DATE:	8-10-09
DRAWN:	C.M.
CHECKED:	C.D.
PROJECT NO.:	26183
SCALE:	AS NOTED

DRAWING NO.:



☐ FULL-SIZE, 22x34 □ HALF-SIZE, 11x17

ROOF PLAN SCALE: 1/4"=1'-0"

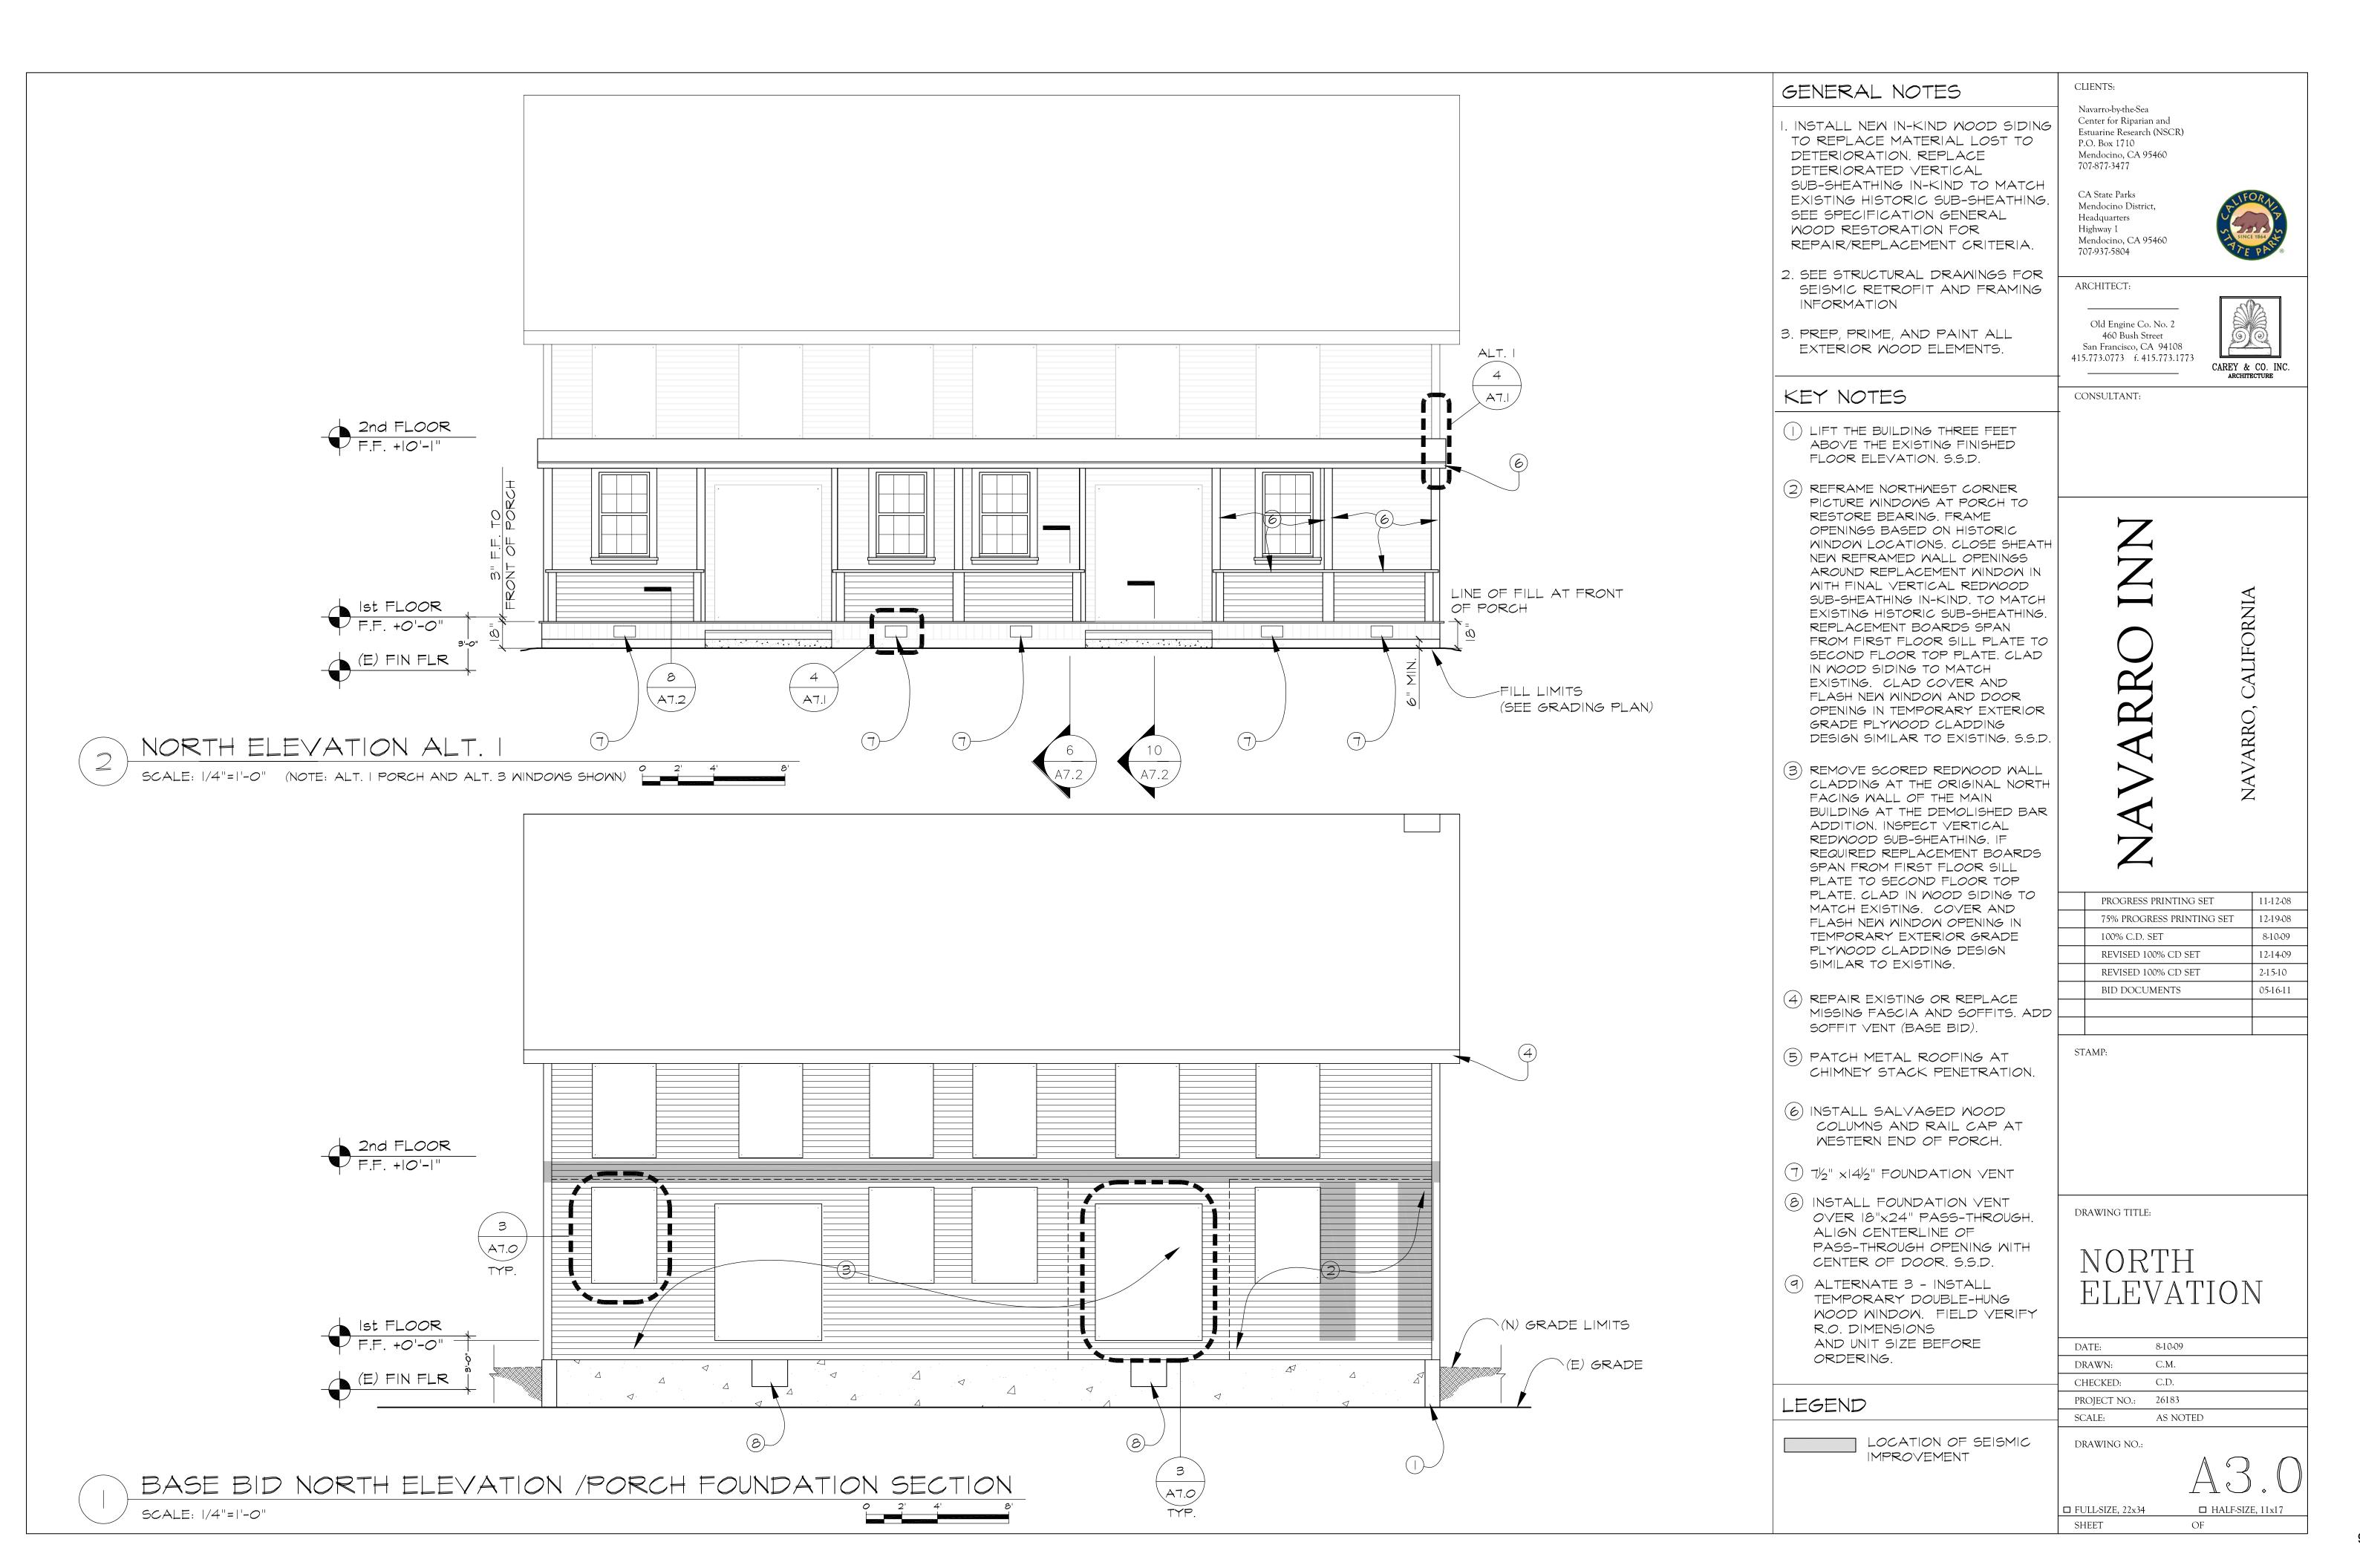

a

